

Current Lower Floor



CUSTOM HOMES
REMODELS
ADDITIONS
253.282.2277

PAVEL2TRAVEL@GMAIL.COM

SCALE:

1/4" = 1'-0"

ENGINEERING:

BLDG DEPT:

MERCER ISLAND

CHECKED BY:

PRINT DATE:

12.920

REVISIONS

12.920 PRELIMINARY PVS

BUILDER APPROVAL:

DATE

OWNER APPROVAL:

DATE

DATE

PLAN NUMBER

PROJECT

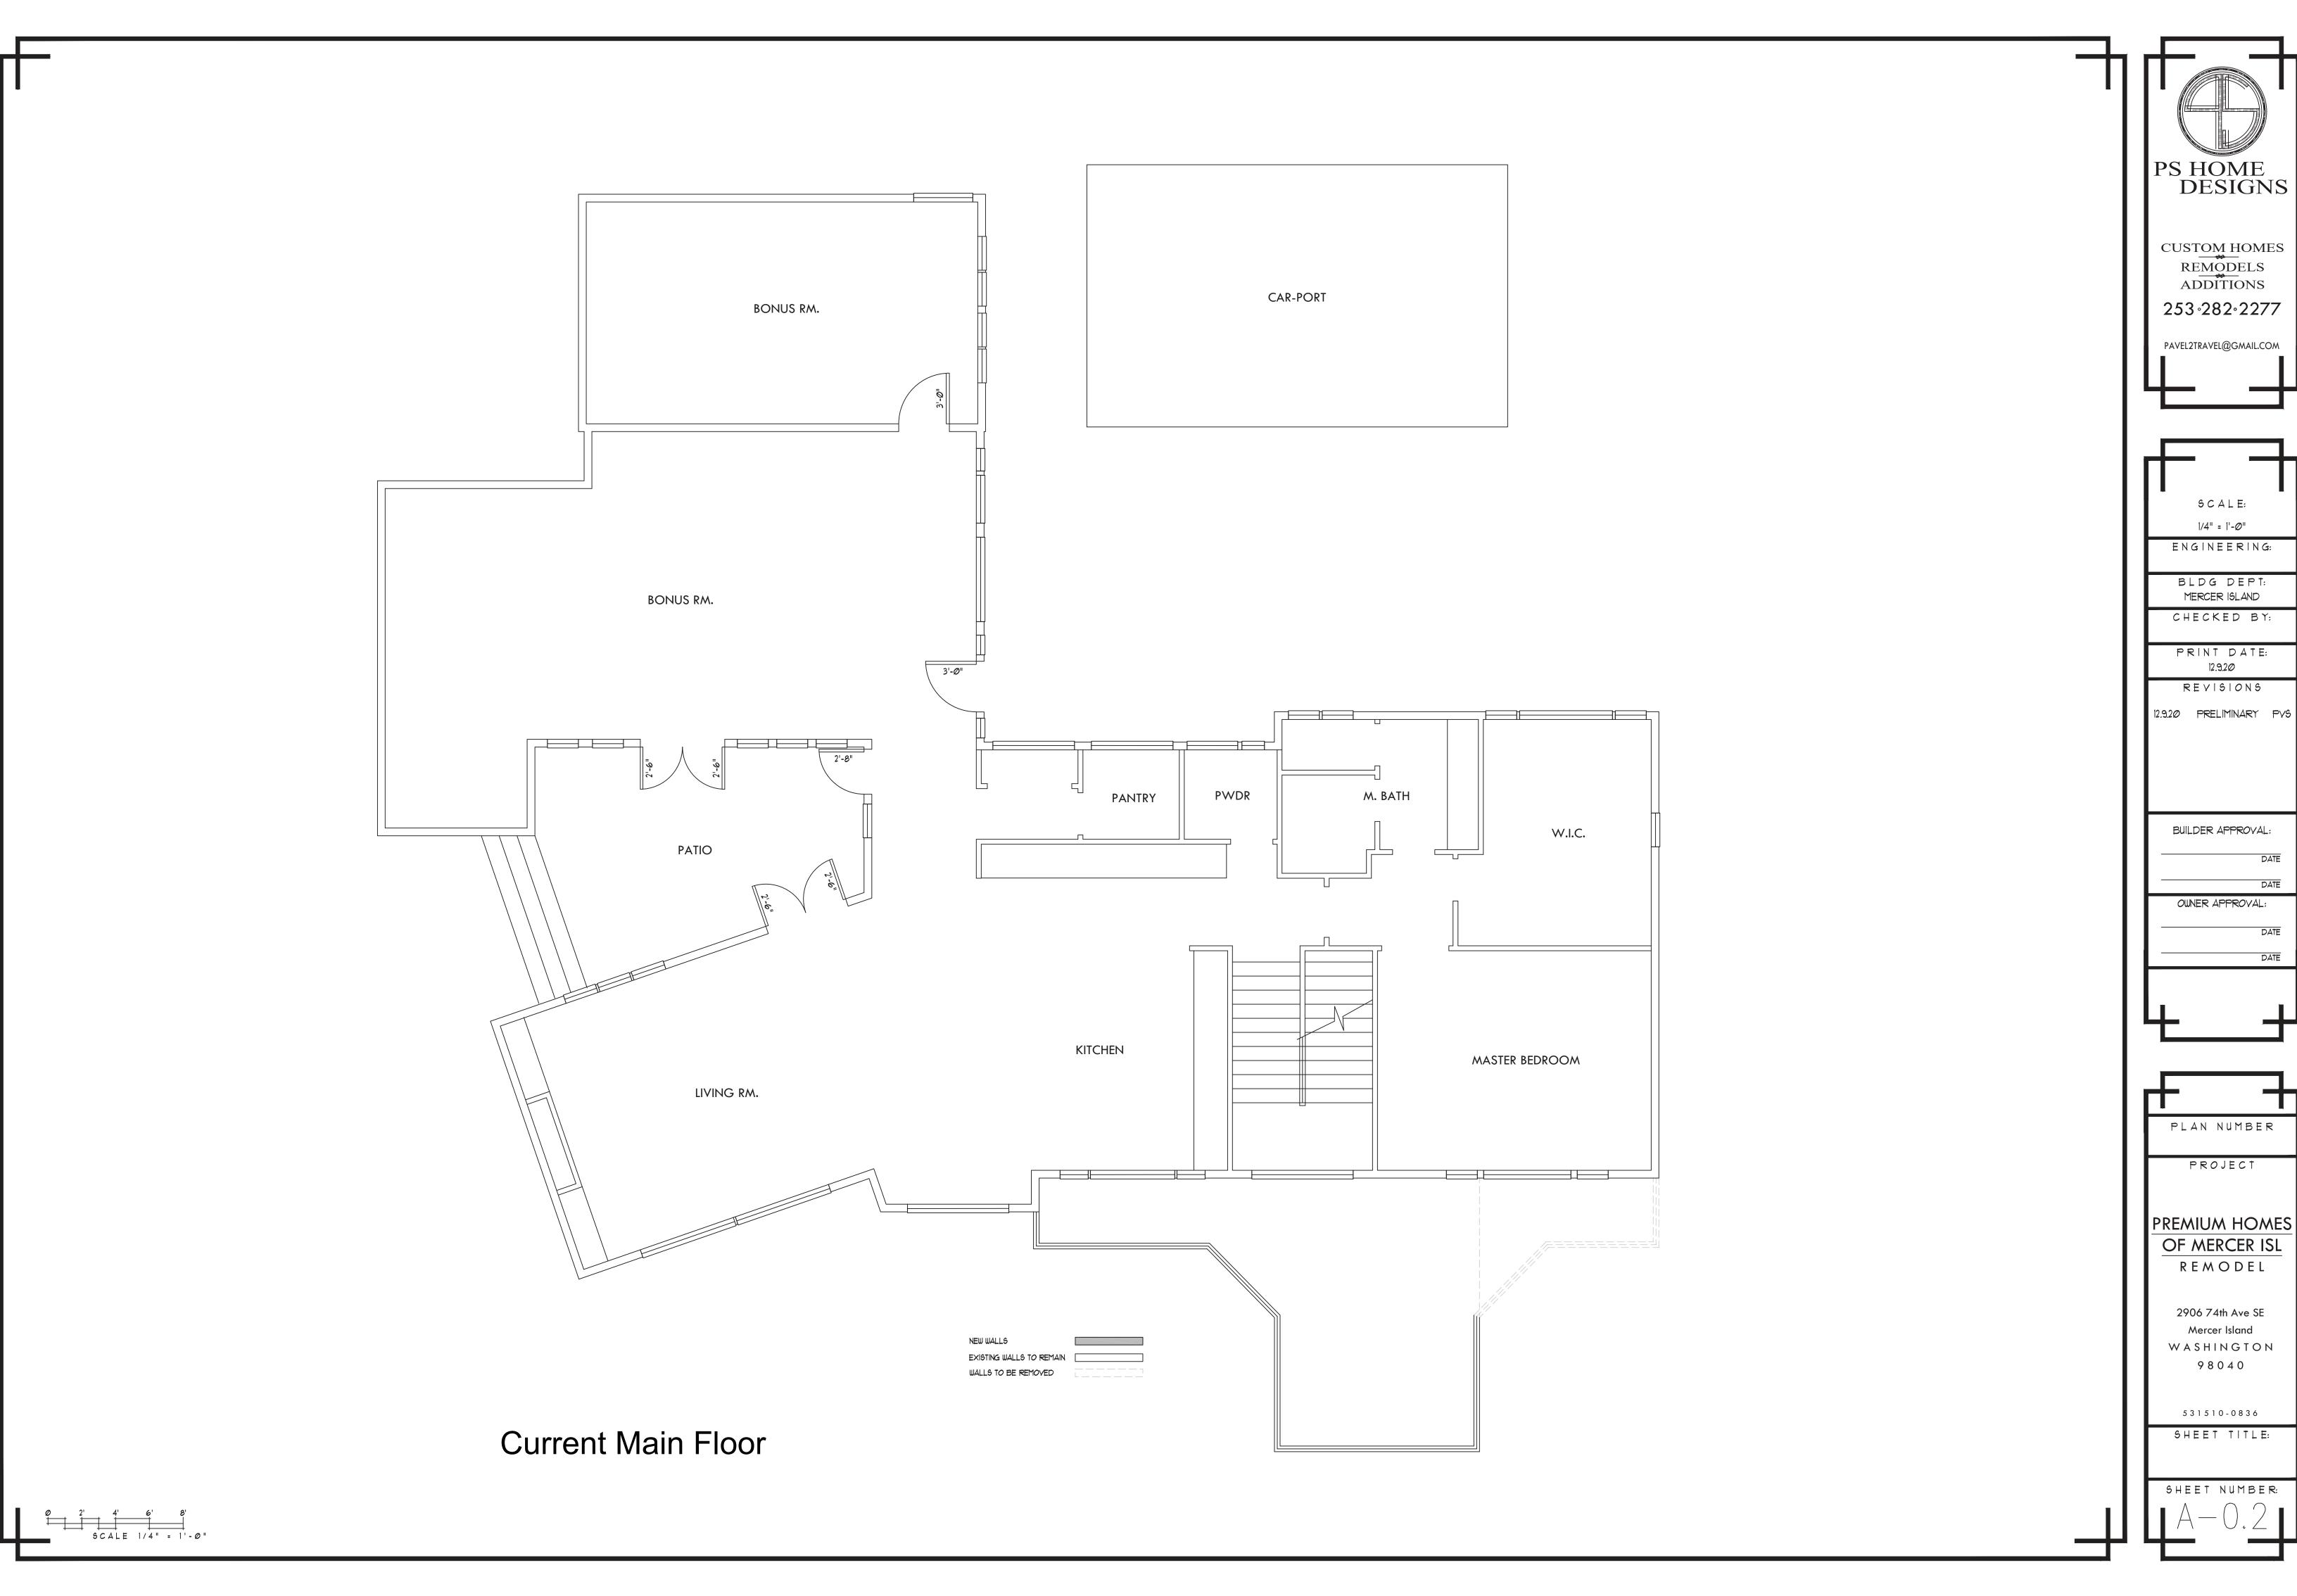
PREMIUM HOMES
OF MERCER ISL
REMODEL

2906 74th Ave SE Mercer Island W A S H I N G T O N 9 8 0 4 0

531510-0836 SHEET TITLE:

SHEET NUMBER:





INSULATION BAFFLE NOTE:

WHEN EAVE VENTS ARE INSTALLED, BAFFLING OF THE VENT OPENINGS SHALL BE PROVIDED SO AS TO DEFLECT THE INCOMING AIR ABOVE THE SURFACE OF THE INSULATION. BAFFLES SHALL BE RIGID MATERIAL, RESISTANT TO WIND DRIVEN MOISTURE. BAFFLES SHALL BE INSTALLED FROM THE TOP OF THE OUTSIDE OF THE EXTERIOR WALL, EXTENDING INWARD, TO A POINT 6" VERTICALLY ABOVE THE HEIGHT OF NON COMPRESSED INSULATION, AND 12" VERTICALLY ABOVE LOOSE FILL INSULATION

OPEN-BLOWN OR POURED LOOSE FILL INSULATION MAY BE USED IN ATTIC SPACES WHERE THE SLOPE OF THE CEILING IS NOT MORE THAN 3 FEET IN 12 AND THERE IS AT LEAST 30" OF CLEAR DISTANCE FROM THE TOP OF THE BOTTOM CHORD OF THE TRUSS OR CEILING, JOIST TO THE UNDERSIDE OF THE SHEATHING, AT THE ROOF RIDGE.

FIREBLOCKING NOTE:

PROVIDE 2"X FIREBLOCKING AT ALL CONCEALED SPACES OF STUD WALLS WAND PARTITIONS INCLUDING FURRED SPACES, AT THE CEILING AND FLOOR LEVELS AND AT 10'-0" INTERVALS BOTH VERTICAL AND HORIZONTAL

SHOWER NOTES

ALL SHOWER RECEPTORS SHALL BE TESTED
FOR WATERTIGHTNESS BY FILLING WITH WATER TO THE
LEVEL OF THE ROUGH THRESHOLD. THE TEST PLUG
SHALL BE SO PLACED THAT BOTH UPPER AND UNDER
SIDES OF THE SUB-PAN SHALL BE SUBJECTED TO THE
TEST AT THE POINT WHERE IT IS CLAMPED TO THE DRAIN

WHEN GYPSUM IS USED AS A BASE FOR TILE WALL PANELS
FOR TUB, SHOWER, OR WATER CLOSET COMPARTMENT WALLS
WATER RESISTANT GYPSUM
BACKING BOARD SHALL BE USED. WATER RESISTANT GYPSUM
BOARD SHALL NOT BE USED IN THE FOLLOWING AREAS
OVER A VAPOR RETARDER

IN AREAS SUBJECT TO CONTINUOUS HIGH HUMIDITY SUCH AS SAUNAS, STEAM ROOMS, OR GANG SHOWER ROOMS. ON CEILINGS WHERE FRAME SPACING EXCEEDS 12" O.C.

EGRESS NOTES

ALL WINDOWS LABELED AS EGRESS ON PLAN MUST MEET THE MINUMUM REQUIREMENTS FOR EGRESS WINDOWS

EGRESS WINDOWS SHALL HAYE A
MINIMUM NET CLEAR OPENING AREA OF
5.7 SQFT. THE MINIMUM NET CLEAR
OPENING HEIGHT SHALL BE 24" THE
MINIMUM NET CLEAR OPENING WIDTH
SHALL BE 20" HEIGHT TIMES THE WIDTH
SHALL NOT BE LESS THAN 5.7 SQFT.

ALL WINDOWS LABELED AS EGRESS ON PLAN SHALL HAVE AN OPENING HEIGHT OF NOT MORE THAN 44" ABOVE FINISHED FLOOR LEVELS PER IRC 310.1

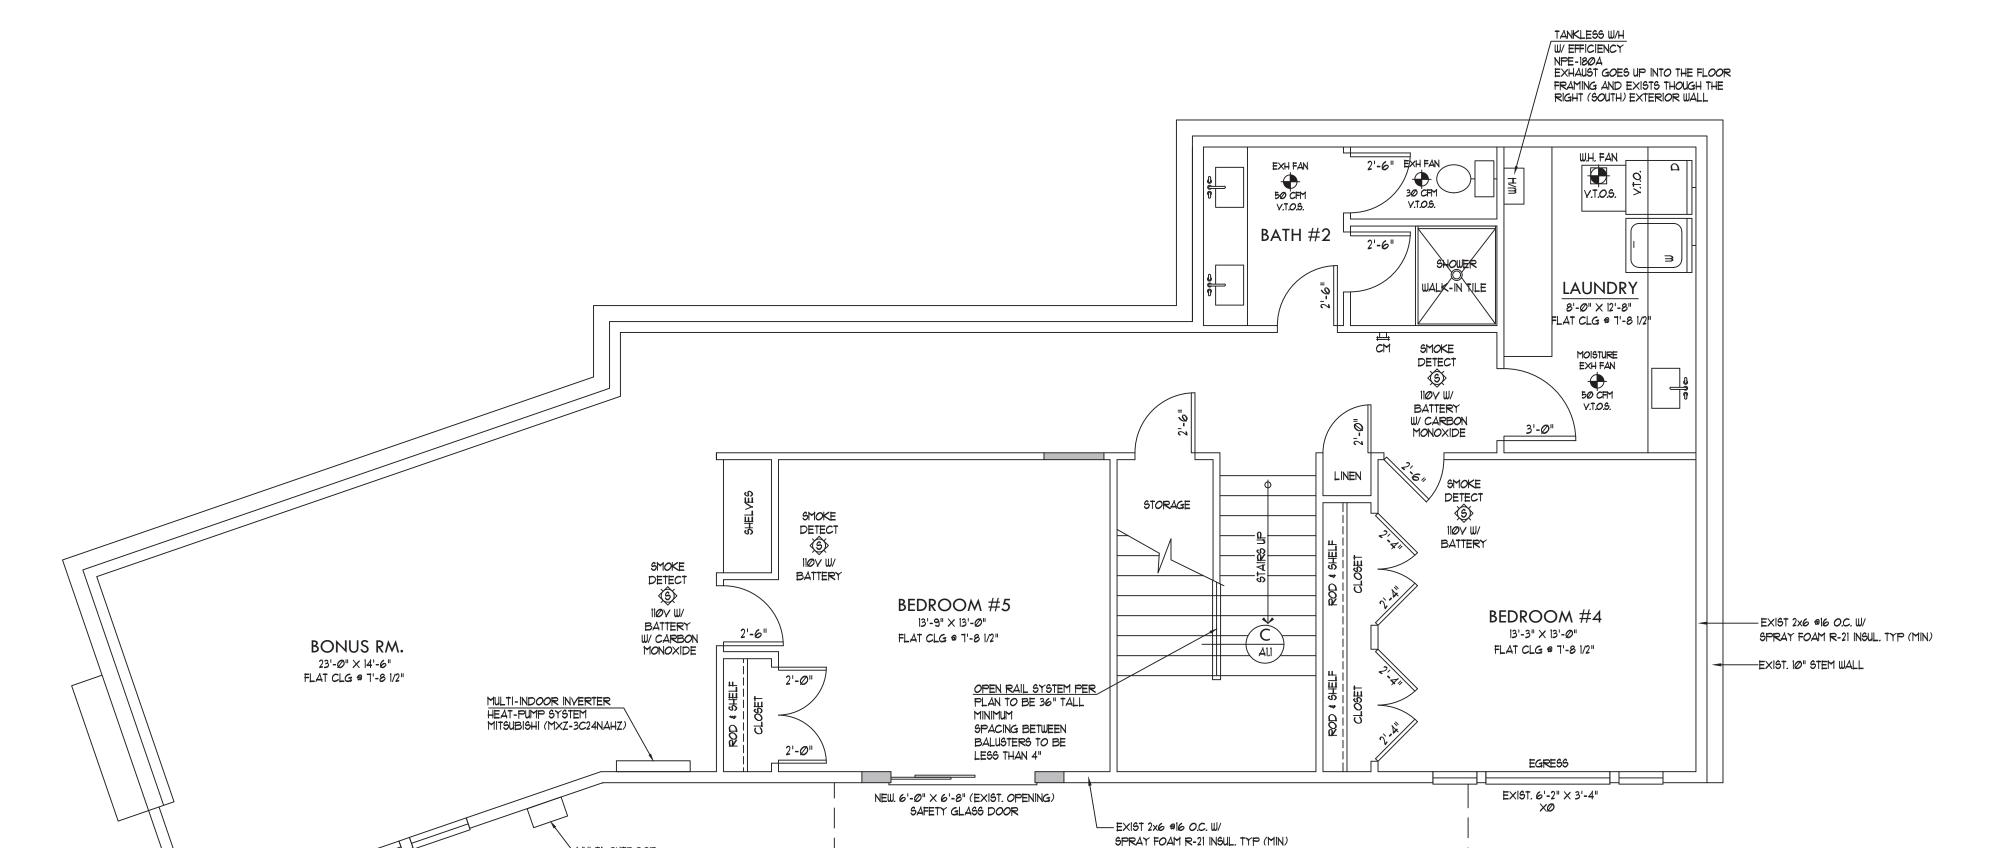


TABLE M 1 5 0 7 . 3 . 3 (1) FAN EFFICACY

CONTINUOUS WHOLE—HOUSE MECHANICAL VENTILATION SYSTEM AIRFLOW RATE REQUIREMENTS

FLOOR AREA (square feet)

LESS THAN 1,500

1501 - 3,000

3*0*01 - 4500

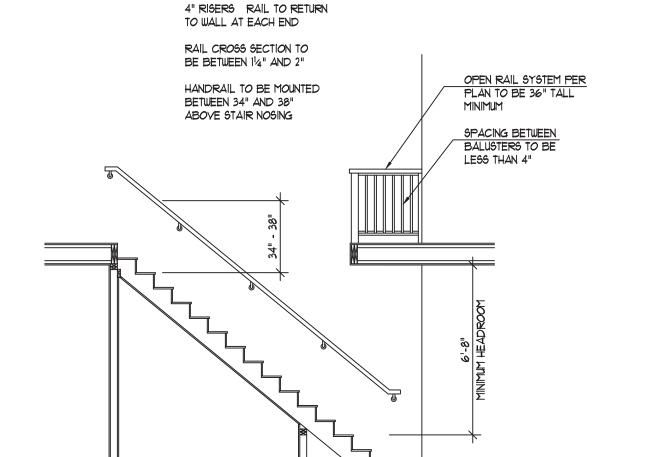
4501 - 6*0*00

6,001 - 7,500

MORE THAN 1,500

0-1 2-3 4-5 6-7

120



HANDRAIL TO BE CONTINUOUS AT ALL STAIRS W/ MORE THAN

C HAND RAIL DETAIL

PROPOSED LOWER FLOOR

0	EXISTING MAIN FLOOR= EXISTING LOWER FLOOR=			2,628 SQ. FT. 1,338 SQ. FT.
		0	TOTAL =	3,966 SQ. FT.
0 0	EXISTING CAR-PORT (TO BE REMOVED)= EXISTING REAR (EAST) DECK= -EXISTING REAR DECK REMOVED = EXISTING (SOUTH) PATIO (TO REMAIN)=			386 5Q. FT. 316 5Q. FT. -52 5Q. FT. 218 5Q. FT.
0	NEW MAIN FLOOR ADDITION=	0	TOTAL =	135 SQ. FT. 135 SQ. FT.
0	NEW ATTACHED GARAGE=			562 SQ. FT.

MULTI-OUTDOOR
HEAT-PUMP SYSTEM
SHALL NOT EXCEED 45 db

WTR HTR NOTES:

IN SEISMIC ZONES D2, WATER
HEATERS SHALL BE ANCHORED OR
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MOTION. STRAPPING SHALL BE AT
POINTS WITHIN THE UPPER THIRD AND
LOWER THIRD OF ITS VERTICAL
DIMENSION

APPLIANCES CAPABLE OF PRODUCING A SPARK OR FLAME LOCATED IN A GARAGE SHALL BE INSTALLED WITH THE PILOT AND BURNERS OR HEATING ELEMENTS AT LEAST IS" ABOVE THE FLOOR SURFACE

NATURAL GAS FIRED FURNACE AND WTR HTR TO VENT TO OUTSIDE

WTR HTR TO HAVE PRESSURE RELIEF VALVE TO DRAIN BY GRAVITY TO OUTSIDE

IN ADDITION TO REQUIRED PRESSURE RELIEF VALVE, AN APPROVED AND LISTED EXPANSION TANK SHALL BE INSTALLED PER THE MANUF, SPECIFICATIONS

SMOKE DETECTOR NOTE:

ALL SMOKE DETECTORS SHOWN ON THE PLAN WITH SYMBOL AT RIGHT TO BE INSTALLED PER 2015 IRC SECTION R314 REFER TO FULL CODE FOR ALL REQUIREMENTS

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ALL DETECTORS TO BE LABELED IN ACCORDANCE WITH UL 217

ALL DETECTORS SHALL RECEIVE THEIR PRIMARY POWER FROM THE BUILDING WIRING AND BE EQUIPT WITH BATTERY BACKUP WHEN THE PRIMARY POWER IS INTERRUPTED

WHERE MULTIPLE DETECTORS ARE SHOWN ON THE PLAN, THE DEVICES SHALL BE INTERCONNECTED IN SUCH A MANNER THAT THE ACTIVATION OF ONE ALARM WILL ACTIVATE ALL OF THE ALARMS IN THE ENTIRE SFR STRUCTURE

R314.3 LOCATION

- SMOKE ALARMS SHALL BE INSTALLED IN THE FOLLOWING LOCATIONS:

 1. IN EACH SLEEPING ROOM.
- IN EACH SLEEPING ROOM.
 OUTSIDE EACH SEPERATE SLEEPING AREA IN THE IMMEDIATE VICINITY OF THE BEDROOMS.
- 3. ON EACH ADDITIONAL STORY OF THE DWELLING, INCLUDING BASEMENTS AND HABITABLE ATTICS BUT NOT INCLUDING CRAWL SPACE AND UNINHABITABLE ATTICS. IN DWELLINGS OR DWELLING UNITS WITH SPLIT LEVELS AND WITHOUT AN INTERVENING DOOR BETWEEN THE ADJACENT LEVELS, A SMOKE ALARM INSTALLED ON THE UPPER LEVEL SHALL SUFFICE FOR THE ADJACENT LOWER LEVEL IS LESS THAN ONE FULL STORY BELOW UPPER LEVEL.
- 4. SMOKE ALARMS SHALL BE INSTALLED NOT LESS THAN 3 FEET HORIZONTALLY FROM THE DOOR OR OPENING OF A BATHROOM CONTAINS A BATHTUB OR SHOWER UNLESS THIS WOULD PROVENT PLACEMENT OF A SMOKE ALARM REQUIRED BY SECTION R314.3
- 5. IN NAPPING AREAS IN A FAMILY HOME CHILD CARE.

R314.3.1 ALTERATIONS, REPAIRS, & ADDITION

WHEN ALTERATIONS, REPAIRS OR ADDITIONS REQUIRING:
A PERMIT OCCUR, OR WHEN ONE OR MORE SLEEPING: ROOMS
ARE ADDED OR CREATED IN EXISTING DWELLINGS, THE
INDIVIDUAL DWELLING: UNIT SHALL BE EQUIPPED WITH
SMOKE ALARMS AS REQUIRED FOR NEW DWELLINGS.

CARBON MONOXIDE ALARMS

ALL CARBON MONOXIDE DETECTORS
SHOWN ON THE PLAN WITH SYMBOL
TO THE RIGHT SHALL BE INSTALLED
PER 2015 IRC SECTION R315 REFER TO FULL
CODE FOR ALL REQUIREMENTS

ALL DETECTORS TO BE LABELED IN ACCORDANCE WITH UL 2034 FOR SINGLE STATION ALARMS

R315.2.2 ALTERNATIONS, REPAIRS, AND ADDITIONS

EXISTING DWELLING SHALL BE EQUIPPED WITH CARBON MONOXIDE ALARMS IN ACCORDANCE WITH SECTION R315.2.1. AN INSPECTION WILL OCCUR WHEN ALTERATIONS, REPAIRS OR ADDITIONS REQUIRING A PERMIT OCCUR, OR WHEN ONE OR MORE SLEEPING ROOMS ARE ADDED OR CREATED.

R315.3 LOCATION

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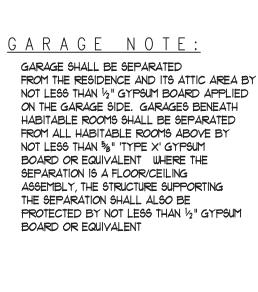
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531510-0836 SHEET TITLE:

PROPOSED
MAIN FLOOR PLAN
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SHOWER NOTES

ALL SHOWER RECEPTORS SHALL BE TESTED FOR WATERTIGHTNESS BY FILLING WITH WATER TO THE LEVEL OF THE ROUGH THRESHOLD. THE TEST PLUG SHALL BE SO PLACED THAT BOTH UPPER AND UNDER SIDES OF THE SUB-PAN SHALL BE SUBJECTED TO THE TEST AT THE POINT WHERE IT IS CLAMPED TO THE DRAIN

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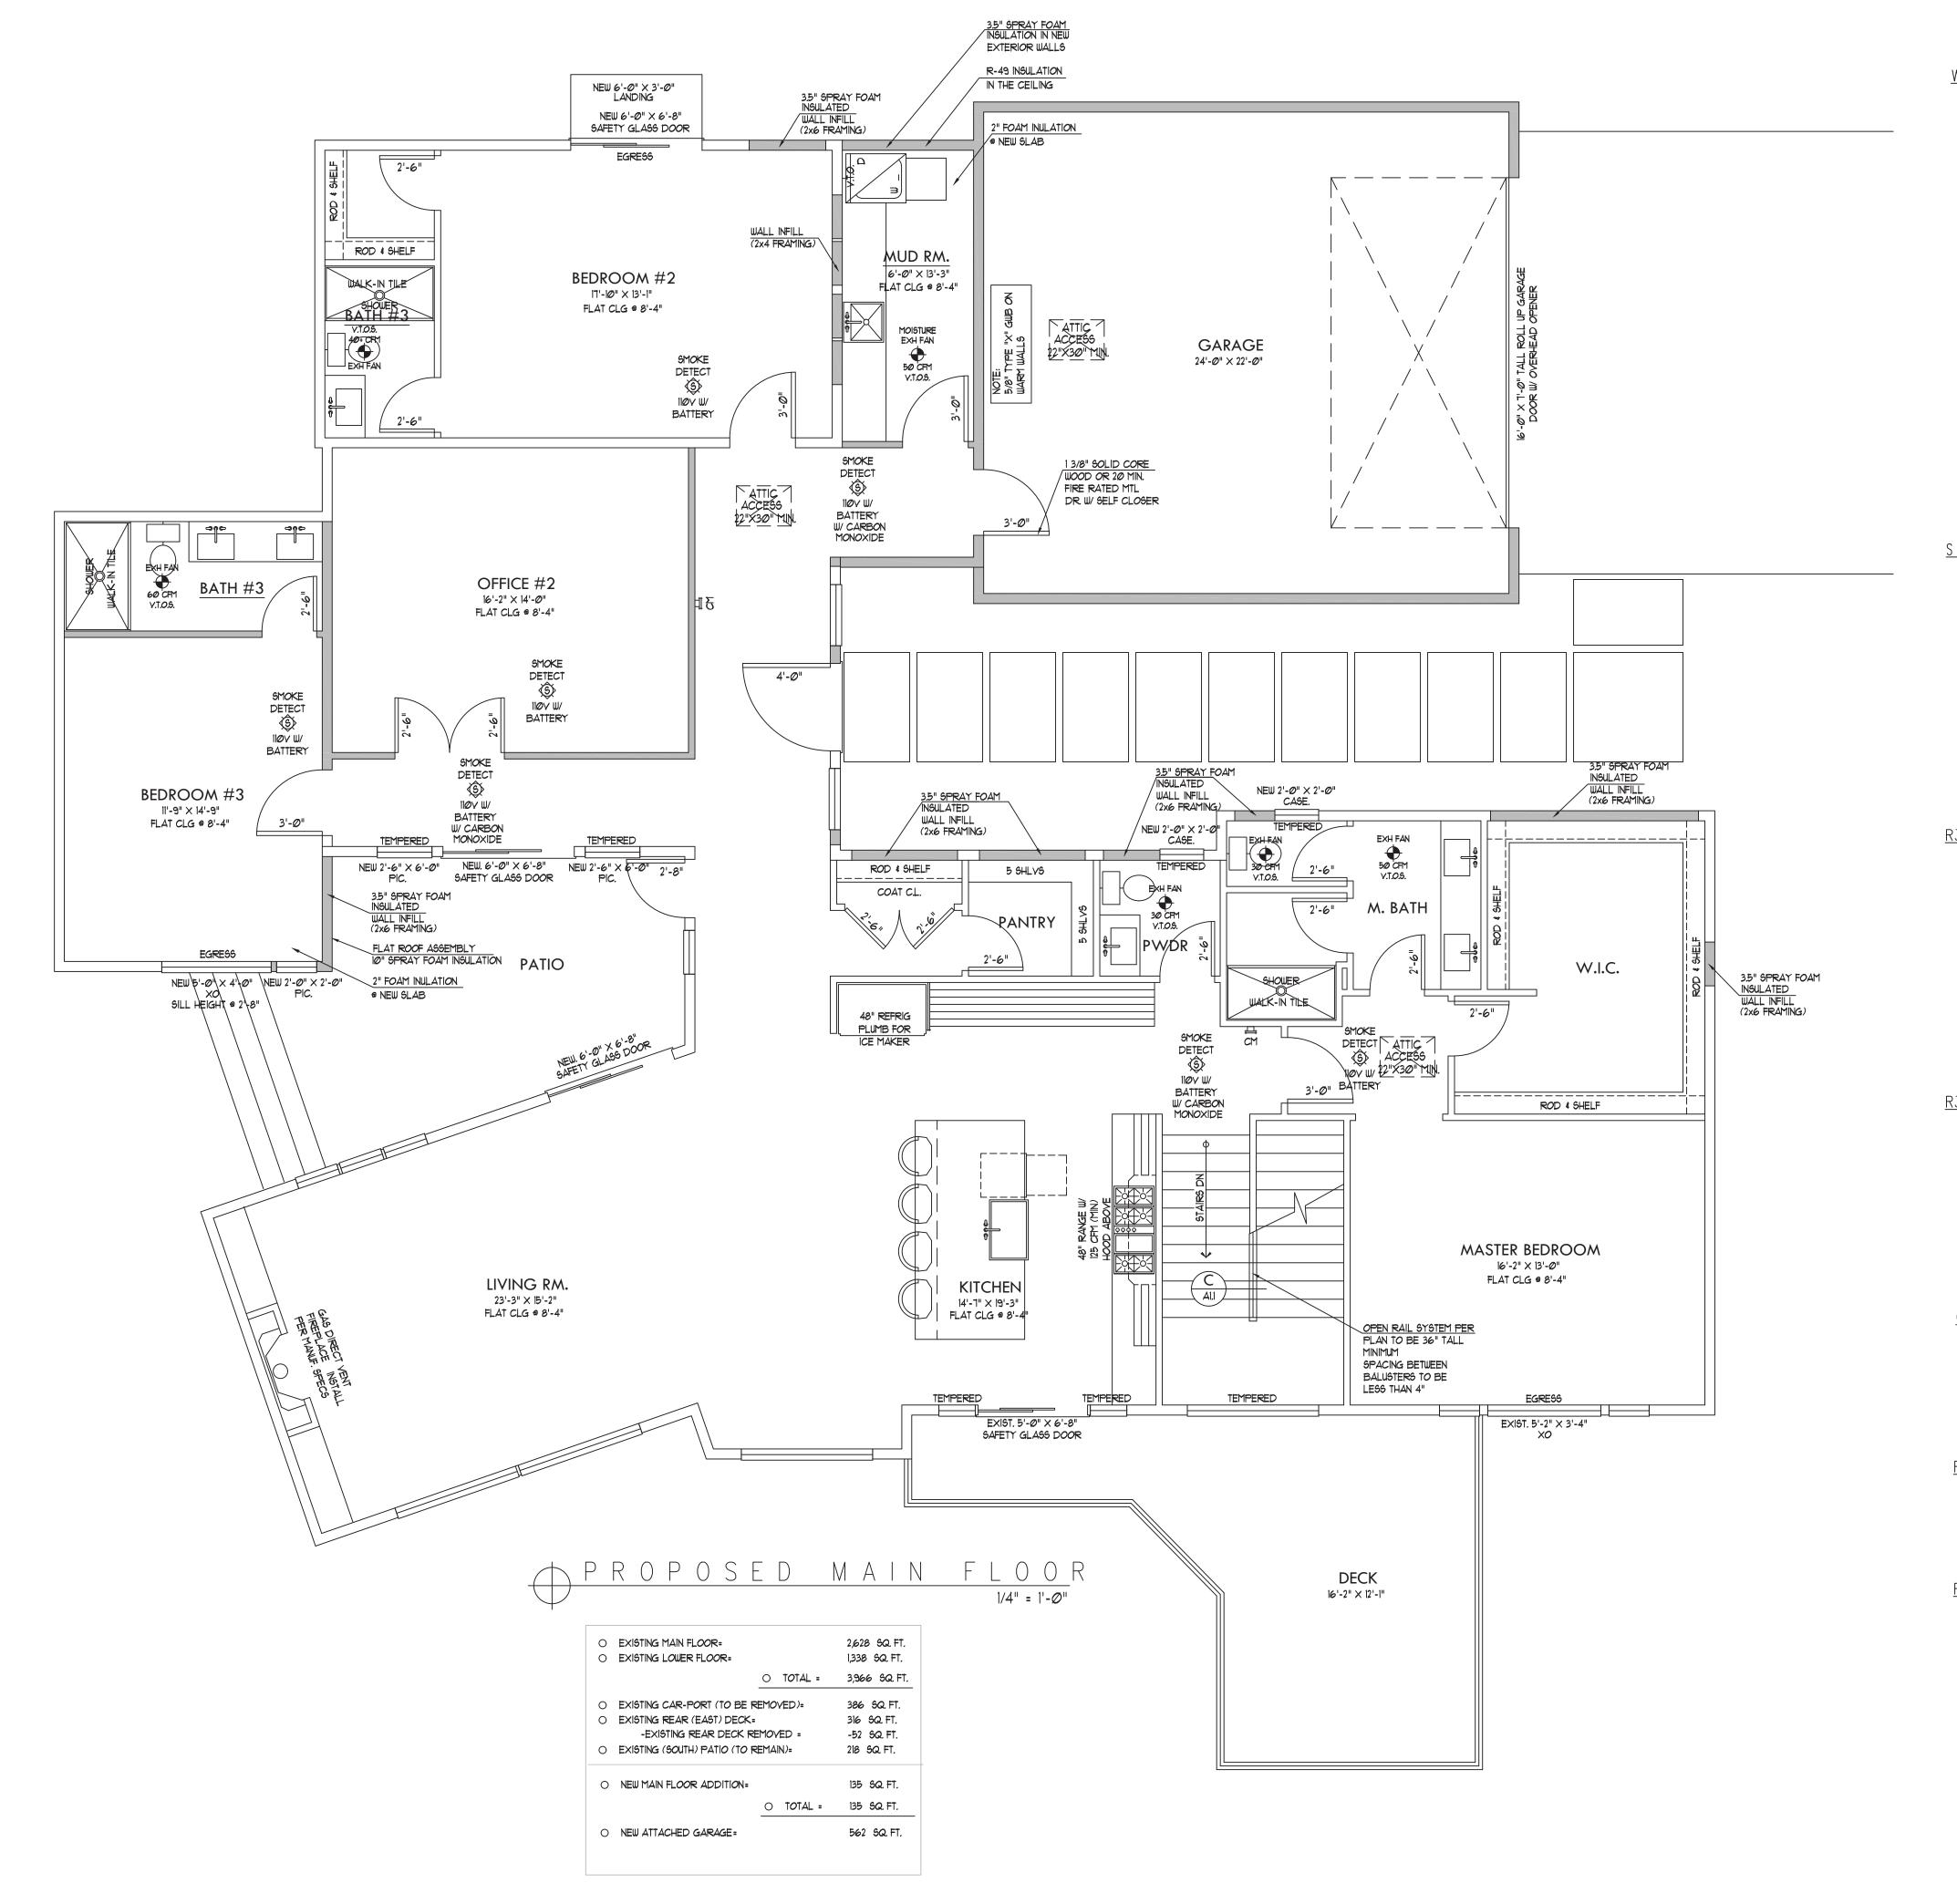
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SHALL NOT BE LESS THAN 5.7 SQFT.

ALL WINDOWS LABELED AS EGRESS ON PLAN SHALL HAVE AN OPENING HEIGHT OF NOT MORE THAN 44" ABOVE FINISHED FLOOR LEVELS PER IRC 310.1

TEMPERED GLAZING NOTE

WINDOWS LABELED 'TEMPERED' ON FLOOR PLAN SHALL COMPLY WITH 2015 IRC FOR MANUF. LABEL DESIGNATING THE TYPE AND THICKNESS OF GLASS AND THE SAFETY GLAZING STANDARD WITH WHICH IT COMPLIES AND SHALL BE VISIBLE IN THE FINAL INSTALLATION

AREAS REQUIRING SAFETY GLAZING SHALL BE NOTED ON THE FLOOR PLAN AND COMPLY WITH 2015 IRC RATINGS STATED ABOVE



WTR HTR NOTES:

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HEATERS SHALL BE ANCHORED OR
STRAPPED TO RESIST HORIZONTAL
DISPLACEMENT DUE TO EARTHQUAKE
MOTION. STRAPPING SHALL BE AT
POINTS WITHIN THE UPPER THIRD AND
LOWER THIRD OF ITS VERTICAL
DIMENSION

APPLIANCES CAPABLE OF PRODUCING A SPARK OR FLAME LOCATED IN A GARAGE SHALL BE INSTALLED WITH THE PILOT AND BURNERS OR HEATING ELEMENTS AT LEAST 18" ABOVE THE FLOOR SURFACE

NATURAL GAS FIRED FURNACE AND WTR HTR TO VENT TO OUTSIDE

WTR HTR TO HAVE PRESSURE RELIEF VALVE TO DRAIN BY GRAVITY TO OUTSIDE

IN ADDITION TO REQUIRED PRESSURE RELIEF VALVE, AN APPROVED AND LISTED EXPANSION TANK SHALL BE INSTALLED PER THE MANUF. SPECIFICATIONS

SMOKE DETECTOR NOTE:

ALL SMOKE DETECTORS SHOWN ON THE PLAN WITH SYMBOL AT RIGHT TO BE INSTALLED PER 2015 IRC SECTION R314 REFER TO FULL CODE FOR ALL REQUIREMENTS

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 1. IN EACH SLEEPING ROOM.
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 2. OUTSIDE EACH SEPERATE SLEEPING AREA IN THE IMMEDIATE
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 3. ON EACH ADDITIONAL STORY OF THE DWELLING, INCLUDING BASEMENTS AND HABITABLE ATTICS BUT NOT INCLUDING CRAWL SPACE AND UNINHABITABLE ATTICS. IN DWELLINGS OR DWELLING UNITS WITH SPLIT LEVELS AND WITHOUT AN INTERVENING DOOR BETWEEN THE ADJACENT LEVELS, A SMOKE ALARM INSTALLED ON THE UPPER LEVEL SHALL SUFFICE FOR THE ADJACENT LOWER
- LEVEL IS LESS THAN ONE FULL STORY BELOW UPPER LEVEL.

 4. SMOKE ALARMS SHALL BE INSTALLED NOT LESS THAN 3 FEET HORIZONTALLY FROM THE DOOR OR OPENING OF A BATHROOM CONTAINS A BATHTUB OR SHOWER UNLEST HIS WOLLD BY SECTION BY
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R314.3.1 ALTERATIONS, REPAIRS, & ADDITION

WHEN ALTERATIONS, REPAIRS OR ADDITIONS REQUIRING:
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CARBON MONOXIDE ALARMS

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TO THE RIGHT SHALL BE INSTALLED
PER 2015 IRC SECTION R315 REFER TO FULL
CODE FOR ALL REQUIREMENTS

ALL DETECTORS TO BE LABELED IN ACCORDANCE WITH UL 2034 FOR SINGLE STATION ALARMS

R315.2.2 ALTERNATIONS, REPAIRS, AND ADDITIONS

EXISTING DWELLING SHALL BE EQUIPPED WITH CARBON MONOXIDE ALARMS IN ACCORDANCE WITH SECTION R3/15.2.1. AN INSPECTION WILL OCCUR WHEN ALTERATIONS, REPAIRS OR ADDITIONS REQUIRING A PERMIT OCCUR, OR WHEN ONE OR MORE SLEEPING ROOMS ARE ADDED OR CREATED.

R315.3 LOCATION

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CUSTOM HOMES
REMODELS
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PAVEL2TRAVEL@GMAIL.COM

253 - 282 - 2277

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1/4" = 1'-0"

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BLDG DEPT:

MERCERISLAND

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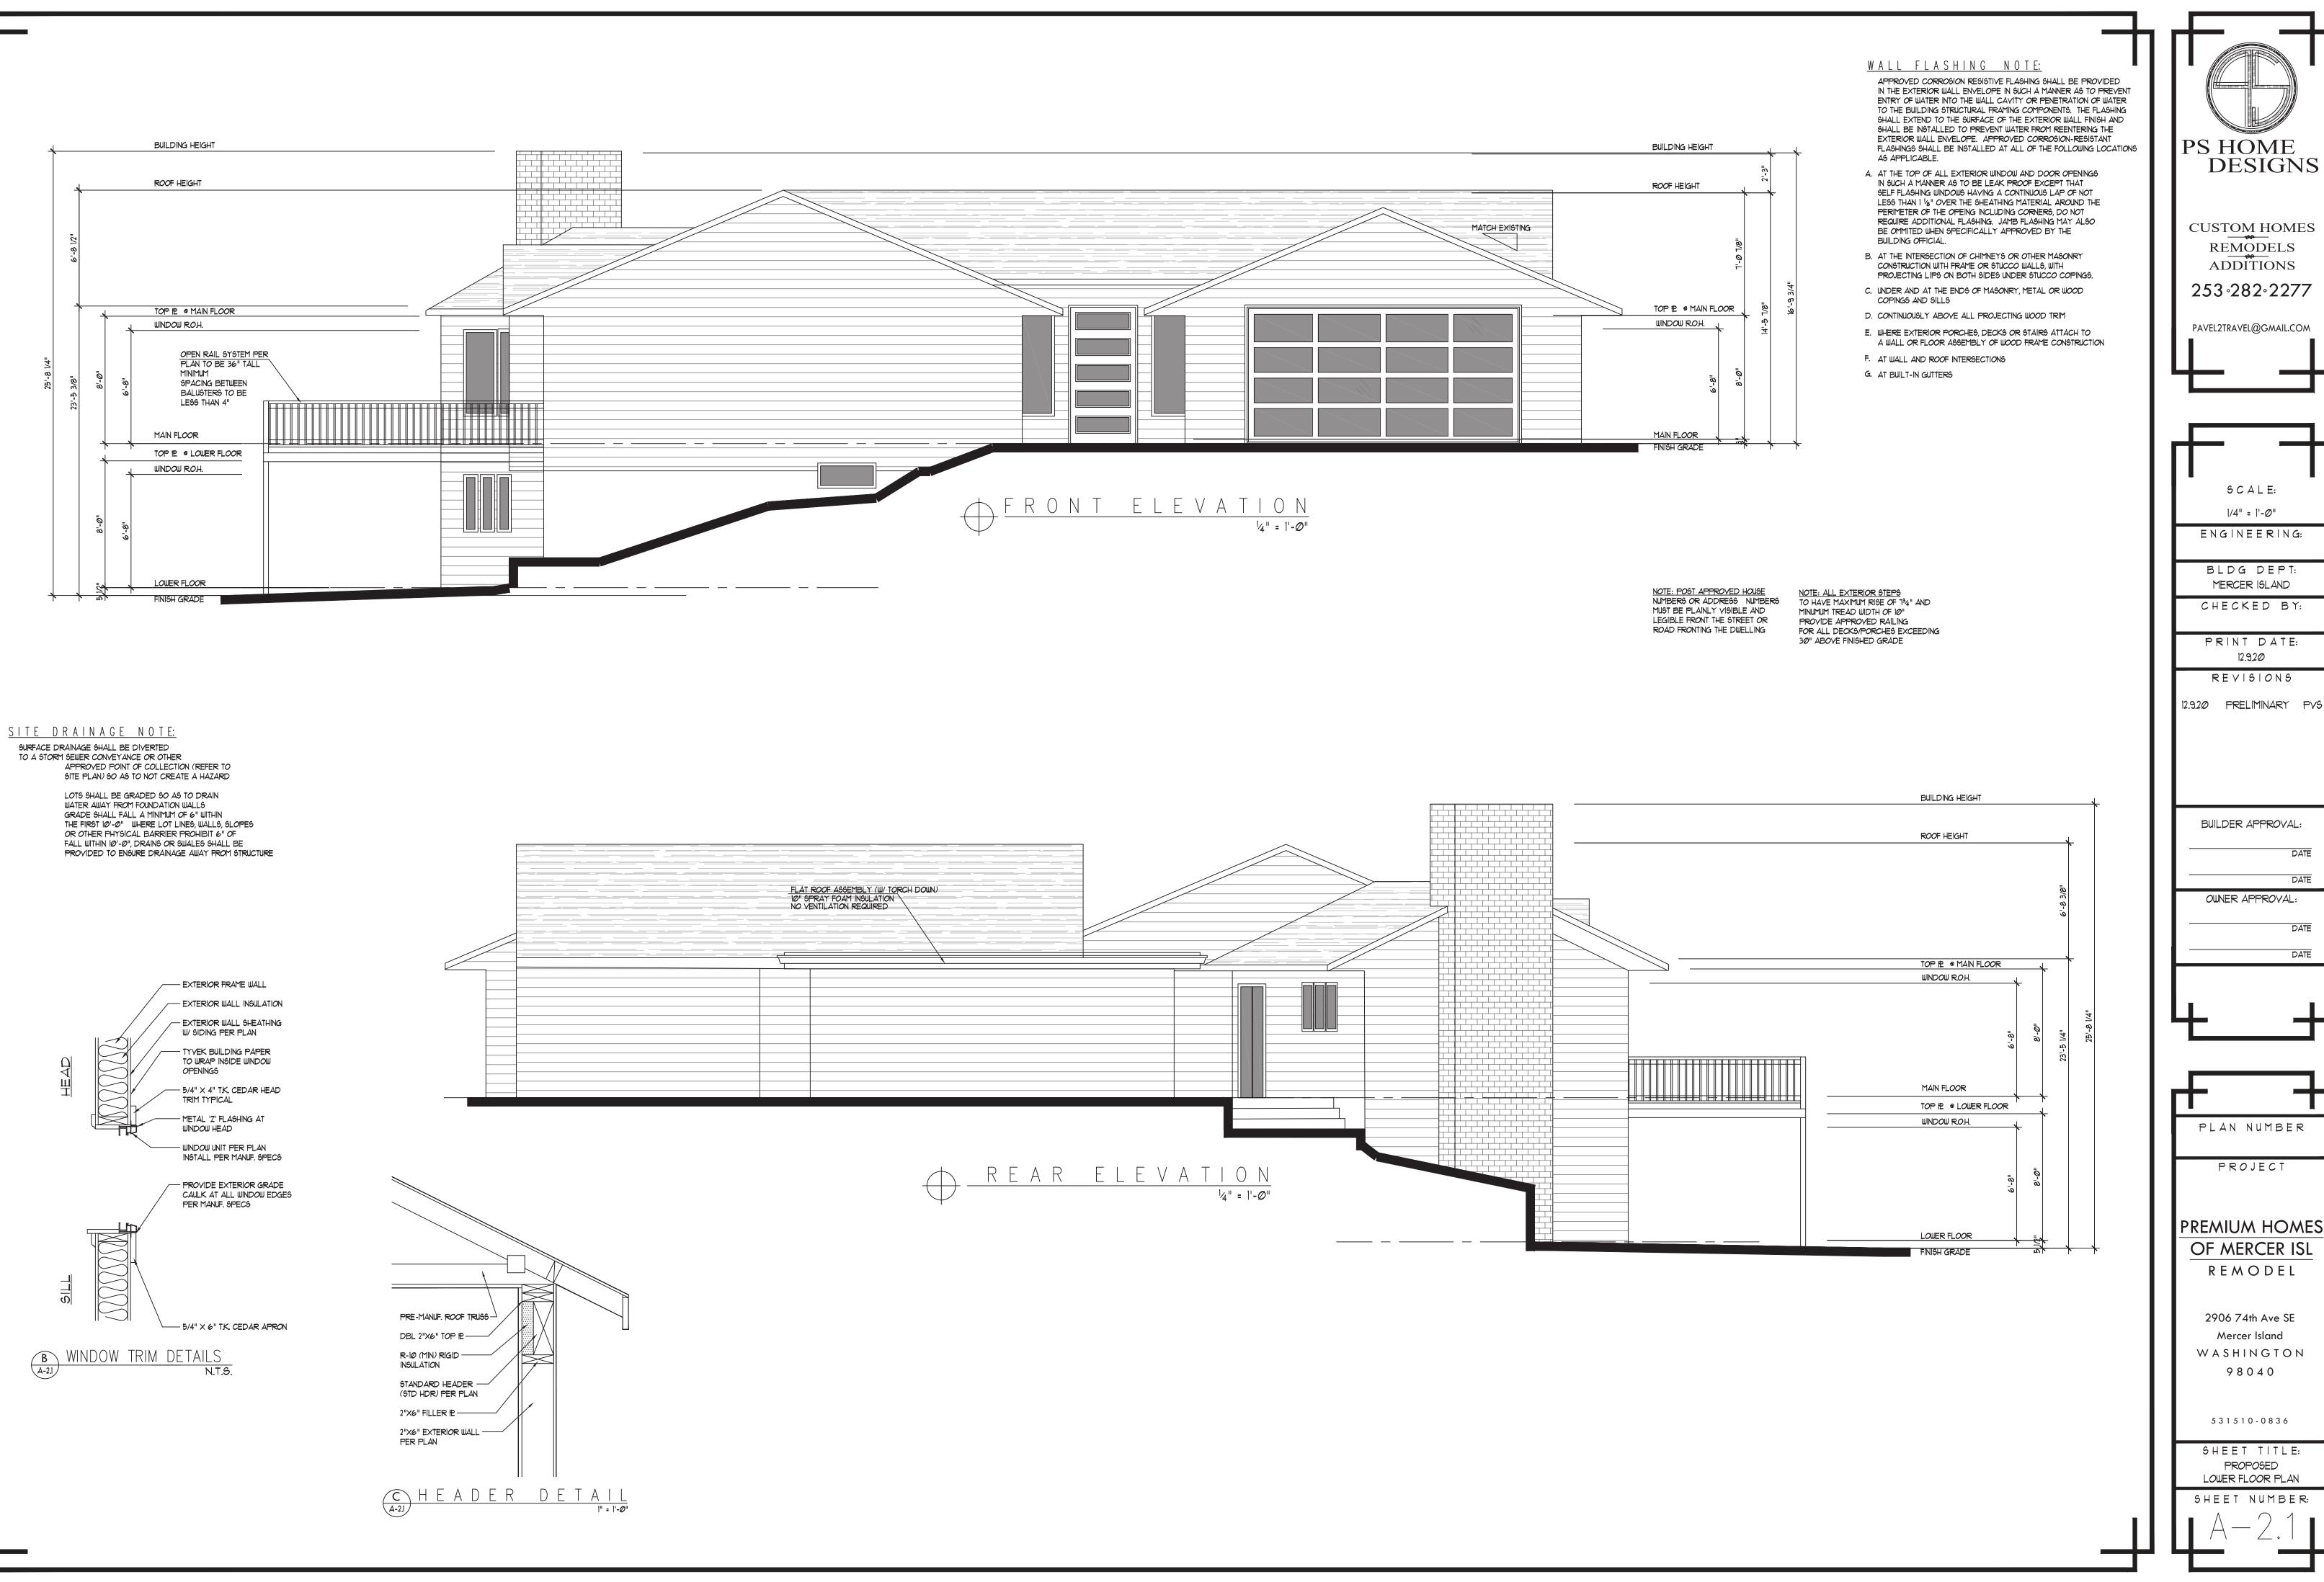
2906 74th Ave SE Mercer Island W A S H I N G T O N 9 8 0 4 0

5 3 1 5 1 0 - 0 8 3 6

PROPOSED
LOWER FLOOR PLAN
SHEET NUMBER:

SHEET TITLE:

A - 1.2





PS HOME **DESIGNS**

CUSTOM HOMES REMODELS **ADDITIONS** 253.282.2277

PAVEL2TRAVEL@GMAIL.COM

SCALE:

1/4" = 1'-Ø"

ENGINEERING: BLDG DEPT: MERCER ISLAND CHECKED BY: PRINT DATE: 12.9.20 REVISIONS 12.9.20 PRELIMINARY PVS BUILDER APPROVAL: DATE OWNER APPROVAL:

PLAN NUMBER PROJECT

OF MERCER ISL REMODEL

2906 74th Ave SE Mercer Island WASHINGTON 98040

531510-0836

SHEET TITLE: PROPOSED LOWER FLOOR PLAN

SHEET NUMBER:

NOTE: POST APPROVED HOUSE NUMBERS OR ADDRESS NUMBERS MUST BE PLAINLY VISIBLE AND LEGIBLE FRONT THE STREET OR ROAD FRONTING THE DWELLING

FLAT ROOF ASSEMBLY (W/ TORCH DOWN)

10" SPRAY FOAM INSULATION

NO VENTILATION REQUIRED

TOP PE @ MAIN FLOOR

WINDOW R.O.H.

FINISH GRADE

NOTE: ALL EXTERIOR STEPS TO HAVE MAXIMUM RISE OF 134" AND MINUMUM TREAD WIDTH OF 10" PROVIDE APPROVED RAILING FOR ALL DECKS/PORCHES EXCEEDING 30" ABOVE FINISHED GRADE

<u>SITE DRAINAGE NOTE:</u>

SURFACE DRAINAGE SHALL BE DIVERTED TO A STORM SEWER CONVEYANCE OR OTHER APPROVED POINT OF COLLECTION (REFER TO SITE PLAN) SO AS TO NOT CREATE A HAZARD

LOTS SHALL BE GRADED SO AS TO DRAIN WATER AWAY FROM FOUNDATION WALLS GRADE SHALL FALL A MINIMUM OF 6" WITHIN THE FIRST 10'-0" WHERE LOT LINES, WALLS, SLOPES OR OTHER PHYSICAL BARRIER PROHIBIT 6" OF FALL WITHIN 10'-0", DRAINS OR SWALES SHALL BE PROVIDED TO ENSURE DRAINAGE AWAY FROM STRUCTURE

BUILDING HEIGHT

TOP E @ MAIN FLOOR

WINDOW R.O.H.

MAIN FLOOR

WINDOW R.O.H.

FINISH GRADE

TOP IE @ LOWER FLOOR

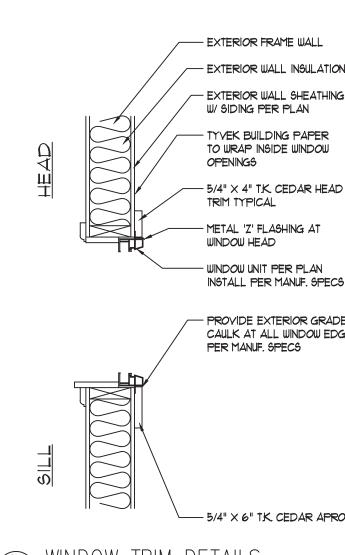
ROOF HEIGHT

WALL FLASHING NOTE:

APPROVED CORROSION RESISTIVE FLASHING SHALL BE PROVIDED IN THE EXTERIOR WALL ENVELOPE IN SUCH A MANNER AS TO PREVENT ENTRY OF WATER INTO THE WALL CAVITY OR PENETRATION OF WATER TO THE BUILDING STRUCTURAL FRAMING COMPONENTS. THE FLASHING SHALL EXTEND TO THE SURFACE OF THE EXTERIOR WALL FINISH AND SHALL BE INSTALLED TO PREVENT WATER FROM REENTERING THE EXTERIOR WALL ENVELOPE. APPROVED CORROSION-RESISTANT FLASHINGS SHALL BE INSTALLED AT ALL OF THE FOLLOWING LOCATIONS AS APPLICABLE.

- A. AT THE TOP OF ALL EXTERIOR WINDOW AND DOOR OPENINGS IN SUCH A MANNER AS TO BE LEAK PROOF EXCEPT THAT SELF FLASHING WINDOWS HAVING A CONTINUOUS LAP OF NOT LESS THAN I 1/2" OVER THE SHEATHING MATERIAL AROUND THE PERIMETER OF THE OPEING INCLUDING CORNERS, DO NOT REQUIRE ADDITIONAL FLASHING. JAMB FLASHING MAY ALSO BE OMMITED WHEN SPECIFICALLY APPROVED BY THE BUILDING OFFICIAL.
- B. AT THE INTERSECTION OF CHIMNEYS OR OTHER MASONRY CONSTRUCTION WITH FRAME OR STUCCO WALLS, WITH PROJECTING LIPS ON BOTH SIDES UNDER STUCCO COPINGS.
- C. UNDER AND AT THE ENDS OF MASONRY, METAL OR WOOD COPINGS AND SILLS
- D. CONTINUOUSLY ABOVE ALL PROJECTING WOOD TRIM
- E. WHERE EXTERIOR PORCHES, DECKS OR STAIRS ATTACH TO
- A WALL OR FLOOR ASSEMBLY OF WOOD FRAME CONSTRUCTION F. AT WALL AND ROOF INTERSECTIONS

G. AT BUILT-IN GUTTERS



EXTERIOR WALL INSULATION - EXTERIOR WALL SHEATHING - 5/4" imes 4" T.K. CEDAR HEAD INSTALL PER MANUF, SPECS PROVIDE EXTERIOR GRADE CAULK AT ALL WINDOW EDGES 5/4" × 6" T.K. CEDAR APRON

<u>SITE DRAINAGE NOTE:</u>

PRE-MANUF. ROOF TRUSS-

STANDARD HEADER -(STD HDR) PER PLAN

2"X6" EXTERIOR WALL -

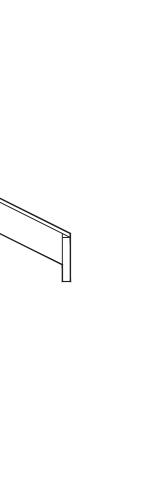
2"X6" FILLER #2 —

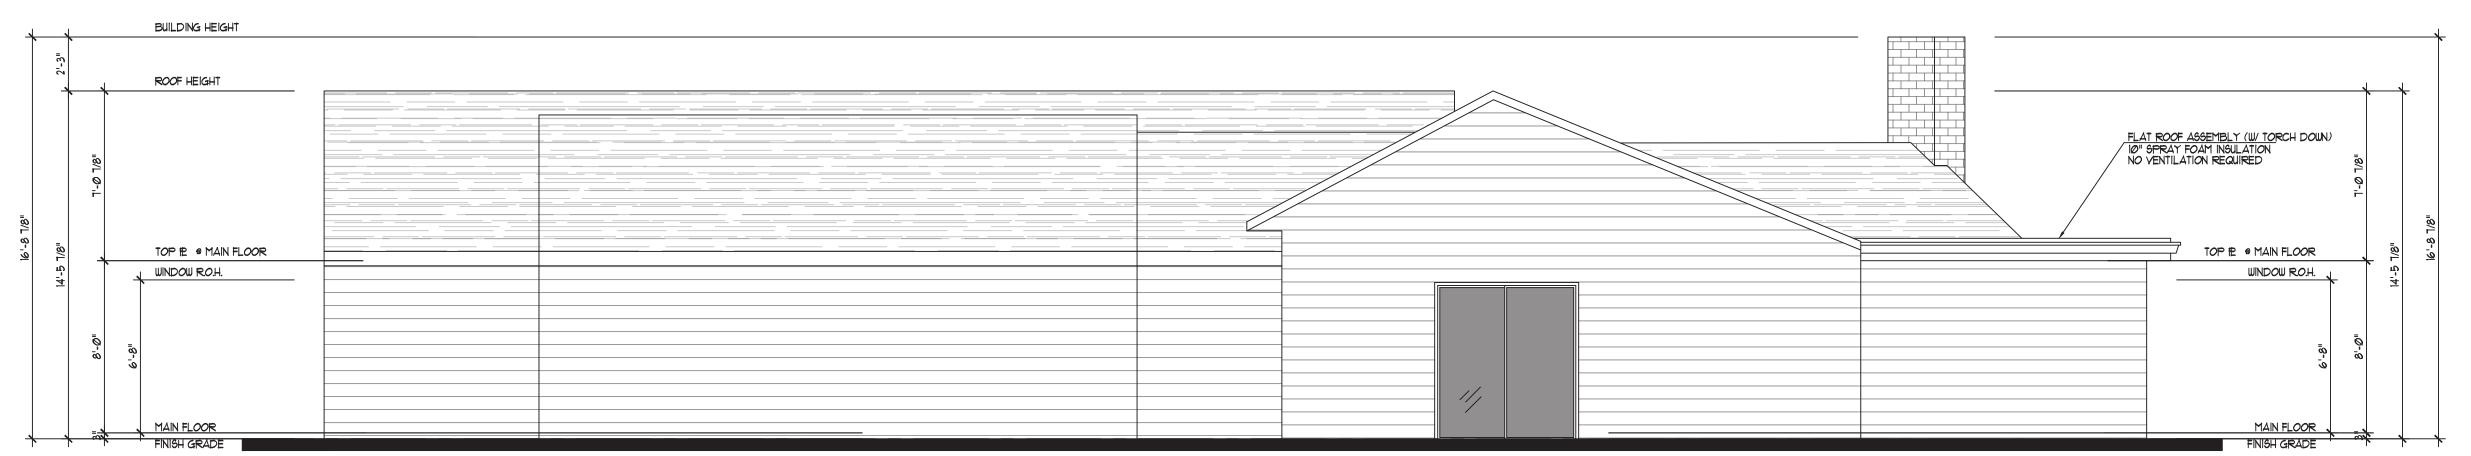
PER PLAN

DBL 2"X6" TOP 12-R-10 (MIN) RIGID -INSULATION

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